

## **BROADWAY ELEVATION**

PREPARED FOR:

**OWNER** 

620 BROADWAY LLC

620 BROADWAY SOMERVILLE, MA

PREPARED BY:

PETER QUINN

259 ELM ST, STE 301

PH (617) 354 3989

SOMERVILLE, MA 02144

ARCHITECTS LLC

**ARCHITECT** 

**SURVEYOR** 

MEDFORD ENGINEERING & SURVEY, ANGELO B. **VENEZIANO ASSOCIATES** 

15 HALL ST, MEDFORD, MA 02155 PH (781) 396-4466

**VERDANT LANDSCAPE ARCHITECTURE** 

BROOKLINE, MA 02446 PH (617) 735-1180

## SPECIAL PERMIT APPLICATION SET FOR

## **REDEVELOPMENT OF** 620 BROADWAY

## SOMERVILLE, MA 02145

LIST OF DRAWINGS		SPECIAL PERMIT APPL. SET 24 JULY 2022	SP APPL. SET REV1 12 DEC 2022	SP APPL. SET REV 2 03 MAR 2023
GENE	RAL			
T1	TITLE SHEET	Х	Х	Х
	EXISTING PLOT PLAN	Х	Х	X
Z1	ZONING ANALYSIS - DIMENSIONAL TABLE	X	Х	X
Z2	ZONING ANALYSIS - DIMENSIONAL SITE PLAN	Х	Х	Х
Z3	ZONING ANALYSIS - LOT COVERAGE	Х	Х	Х
Z4	ZONING ANALYSIS - GROSS FLOOR AREA, BUILDING HEIGHT	Х	Х	Х
Z5	ZONING ANALYSIS - FACADE BUILD OUT, OPEN SPACE, FACADE FENESTRATION	Х	Х	Х
Z6	ZONING ANALYSIS - STOREFRONT FRAME		Х	X
L1	LANDSCAPE PLAN	Х	Х	X
L2	BOTANICA STREETSCAPE	Х	Х	X
L3	CAFE STREETSCAPE	Х	X	X
L4	BACK OF HOUSE	Х	Х	X
L5	GREEN SCORE	Х	X	X
L6	DETAILS	Х	Х	Х
3D-1	AERIAL VIEW 1	X	X	X
3D-2	AERIAL VIEW 2	X	X	X
3D-3	AERIAL VIEW 3	X	X	X
3D-4	AERIAL VIEW 4	X	X	X
3D-5	STREET VIEW 1	X	X	X
3D-6	STREET VIEW 2	X	X	X
A-1	PROPOSED FIRST FLOOR PLAN	X	X	X
A-2	PROPOSED FRONT ELEVATION	X	X	X
A-2a	PROPOSED MATERIAL SHEET	X	X	Х
A-2b	PROPOSED FRONT ELEVATION- Scheme 2			
A-2c	PROPOSED FRONT ELEVATION- Scheme 3	X		
A-3	PROPOSED RIGHT ELEVATION	X	X	X
A-4	PROPOSED REAR ELEVATION	X	X	X
A-5	PROPOSED LIGHTING BLAN	X	X	X
A-6	PROPOSED LIGHTING PLAN	X	X	X
A-7	SIGNAGE PLAN	X	X	X
A-8	BUILDING SECTION	X	X	X
SH-1-3	SHADOW STUDY	^	^	_ ^



REPRESENTS DRAWINGS THAT CHANGED IN THIS REVISION

PLANNING INTERIOR DESIGN

PETER QUINN ARCHITECTS LLC 259 ELM STREET, SUITE 301 SOMERVILLE, MA 02144 PH 617-354-3989

REDEVELOPMENT OF 620 **BROADWAY** 

741 BROADWAY. SOMERVILLE, MA 02144

620 BROADWAY, LLC

620 BROADWAY SOMERVILLE, MA 02145

DRAWING TITLE


COVER SHEET

SCALE AS NOTED REVISION DATE APPL. SET REV2 03 MAR 2023 P APPL. SET REV1 12 DEC. 2022 SP APPLICATION 14 JULY 2022 ZBA APPL. SET

LANDSCAPE ARCHITECT

318 HARVARD ST #25,

LOCUS PLAN

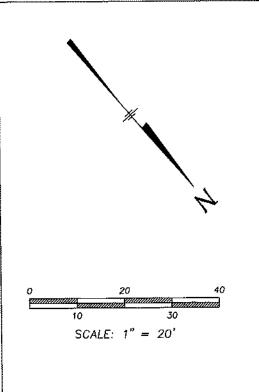

CURRENT OWNER: GASEUS MAXIMUS LLC

TITLE REFERENCE: BK 69469 PG 490

PLAN REFERENCE: 1882 OF 1949, 1621 OF 1972

THIS PLAN WAS PREPARED WITHOUT A FULL TITLE EXAMINATION AND IS NOT A CERTIFICATION TO THE TITLE OF THE LANDS SHOWN. THE OWNERSHIP OF ABUTTING PROPERTIES IS ACCORDING TO ASSESSORS RECORDS. THIS PLAN MAY OR MAY NOT SHOW ALL ENCUMBRANCES WHETHER EXPRESSED, IMPLIED OR PRESCRIPTIVE.


### SURVEYOR'S CERTIFICATION:

TO: ATTY SEAN O'DONAVAN

I CERTIFY THAT THIS PLAN AND THE SURVEY ON WHICH IT IS BASED WERE MADE IN ACCORDANCE WITH THE GENERALLY ACCEPTABLE PRACTICES OF LAND SURVEYORS IN THE COMMONWEALTH OF MASSACHUSETTS FOR A PLAN AND SURVEY OF THIS TYPE. THIS CERTIFICATION IS MADE ONLY TO THE ABOVE NAMED INDIVIDUAL(S) AND IS NULL AND VOID UPON ANY FURTHER CONVEYANCE OF THIS PLAN.

THE FIELD WORK WAS COMPLETED ON: APRIL 4, 2021 DATE OF PLAN: MAY 28, 2021


RICHARD J. MEDE, JR. P.L.S.

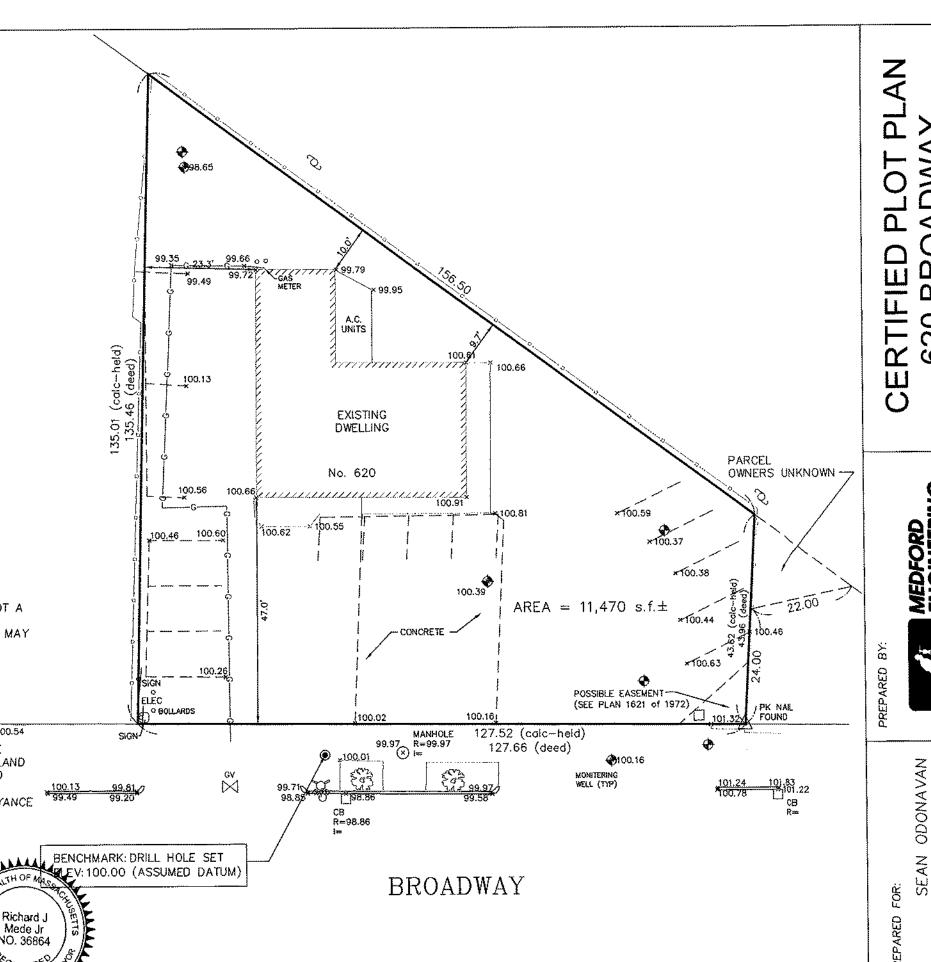

 $\Box$ 

62(

MO

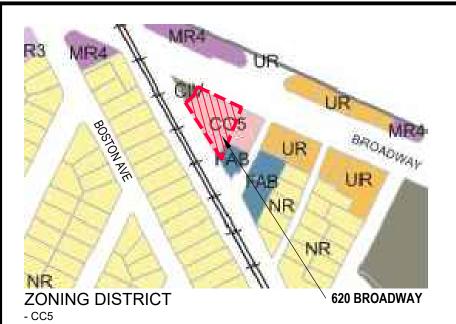

## DIMENSIONAL TABLE FOR 620 BROADWAY

- CC5 ZONING DISTRICT
- QUARTER MILE STATION AREA WALKSHED
- NOT ON A PEDESTRIAN STREET
- COMMERCIAL BUILDING BUILDING TYPE





ALL DIMENSIONS ARE APPROXIMATE & PENDING PLOT PLAN VERIFICATION. SEE DIMENSIONAL SITE PLAN.

2. CANNABIS SALE USE REQUIRES SPECIAL PERMIT PER TABLE 6.2.13.

BIKE PARKING SPACES CALCULATION
4,580-sf cannabis sales / 10,000 = .46 round up to 1 LT.
1,645-sf food&beverage / 5000 = .33 round up to 1 LT.
Total Long Term Bike Parking = 2 LT

4,580-sf cannabis sales / 2.500 = 1.83 round up to 2 ST. 1,645-sf food&beverage / 1000 = 1.64 round up to 2 ST. Total Short Term Bike Parking = 4 LT

4. 6.2.13.c.i

REQUIRED USE:

A minimum of five percent (5%) of the gross floor area of any commercial building or lab building must be provided as leasable floor area for uses from the arts & creative enterprise use category

TOTAL GROSS FLOOR AREA: 6,961 GSF PROPOSED ARTS ENTERPRISE SPACE: 355 GSF = 5% OF GSF (MIN 348 SF)

	ITEM		ALLOWED/ REQUIRED	EXISTING	PROPOSED	COMPLIANCE
	BUILDING TYPE		PER 6.2.6.b	GAS STATION	COMMERCIAL BLDG	COMPLIES
F	LOT AREA			11,470-SF	NO CHANGE	
	LOT WIDTH		30' MIN	127.52'	NO CHANGE	COMPLIES
LOT	LOT DEPTH			89.3'	NO CHANGE	
	LOT COVERAGE (%)		100% MAX	0	71%	COMPLIES
	GREEN SCORE		0.2 MIN, 0.25 IDEAL	0	.28	COMPLIES
	OPEN SPACE		25% MIN	0%	37%	COMPLIES
S	PRIMARY FRONT SETBACK		2' MIN, 15' MAX	47'	2'	COMPLIES
3ACK	SIDE YARD SETBACK (LEFT / EAST)		NONE	23.3'	5.3'	COMPLIES
SETBACKS	SIDE YARD SETE	BACK (RIGHT / WEST)	NONE	60.5'	18'	COMPLIES
	REAR SETBACK		0 MIN	9.7'	10'	COMPLIES
PARKING SETBACKS	PRIMARY FRONT	Г SETBACK	30' MIN		NO PARKING	COMPLIES
PARK SETB/	SECONDARY FR	ONT SETBACK	30' MIN		NO PARKING	COMPLIES
	PRIMARY FACAD	DE BUILDOUT (%)	80% MIN		80%	COMPLIES
	FLOOR PLATE		30,000-SF MAX	1,554-SF	6,961-SF	COMPLIES
(1)	WIDTH		200' MAX	44'	102.8'	COMPLIES
SSINC	BUILDING HEIGHT (for proposed 3-STY)		50' MAX	12'	18'	COMPLIES
MAIN MASSING	NUMBER OF STORIES (CC5)		3 MIN, 5 MAX	1	1	ZBA APPROVED
MAIN	GROUND STORY	/ HEIGHT	18' MIN	12'	18'	COMPLIES
	ROOF TYPE		FLAT	GABLE	FLAT	COMPLIES
	PRIMARY FACAD	DE FENESTRATION (%)	70% MIN		78%	COMPLIES
FACADE	CANOPY	WIDTH	≥ DOOR WIDTH		≥ DOOR WIDTH	COMPLIES
FAC	CLEARANCE PROJECTION SETBACK FROM CURB		8FT MIN		15FT	COMPLIES
			3FT MIN		3FT & 4 FT	COMPLIES
			2FT MIN		16.5FT	COMPLIES
>	NUMBER OF PRINCIPAL BUILDINGS		1 MAX	1	1	COMPLIES
ANC.	USE		PER TABLE 6.2.13	GAS STATION	CANNABIS SALES	REQUIRES SP
USE & OCCUPANCY					CAFE	COMPLIES
8	PER TABLE 6.2.13.c.i ARTS ENTERPRISE SPACE		5% MIN		355 SF (MIN 348 SF)	COMPLIES
	NO. OF PARKING SPACES		0 MIN	13	0	COMPLIES
≽	NO. OF BIKE PARKING SPACES		2LT, 4ST	0	0 12LT, 16ST See Note 3 / Z1	
!	ENTRANCE SPACING		201 MAY		29.8' MAX	COMPLIES
MOBILITY	ENTRANCE SPA	CING	30' MAX		29.0 IVIAA	COMI LILO



ARCHITECTURE PLANNING INTERIOR DESIGN

PETER QUINN ARCHITECTS LL0 259 ELM STREET, SUITE 301 SOMERVILLE, MA 02144 PH 617-354-3989



CONSULTANT

REDEVELOPMENT
OF 620

**BROADWAY** 

741 BROADWAY, SOMERVILLE, MA 02144

620 BROADWAY, LLC

620 BROADWAY SOMERVILLE, MA 02145

DRAWING TITLE

ZONING ANALYSIS -DIMENSIONAL TABLE

SCALE AS NOTE

SCALE AS NOTED					
REVISION	DATE				
SP APPL. SET REV2	03 MAR 2023				
SP APPL. SET REV1	12 DEC. 2022				
SP APPLICATION	14 JULY 2022				
UDC SET Progress	11 MARCH 202				
ZBA APPL. SET	16 NOV 202				


IVI I

*7*-1


REVIEWED BY



- QUARTER MILE WALKSHED

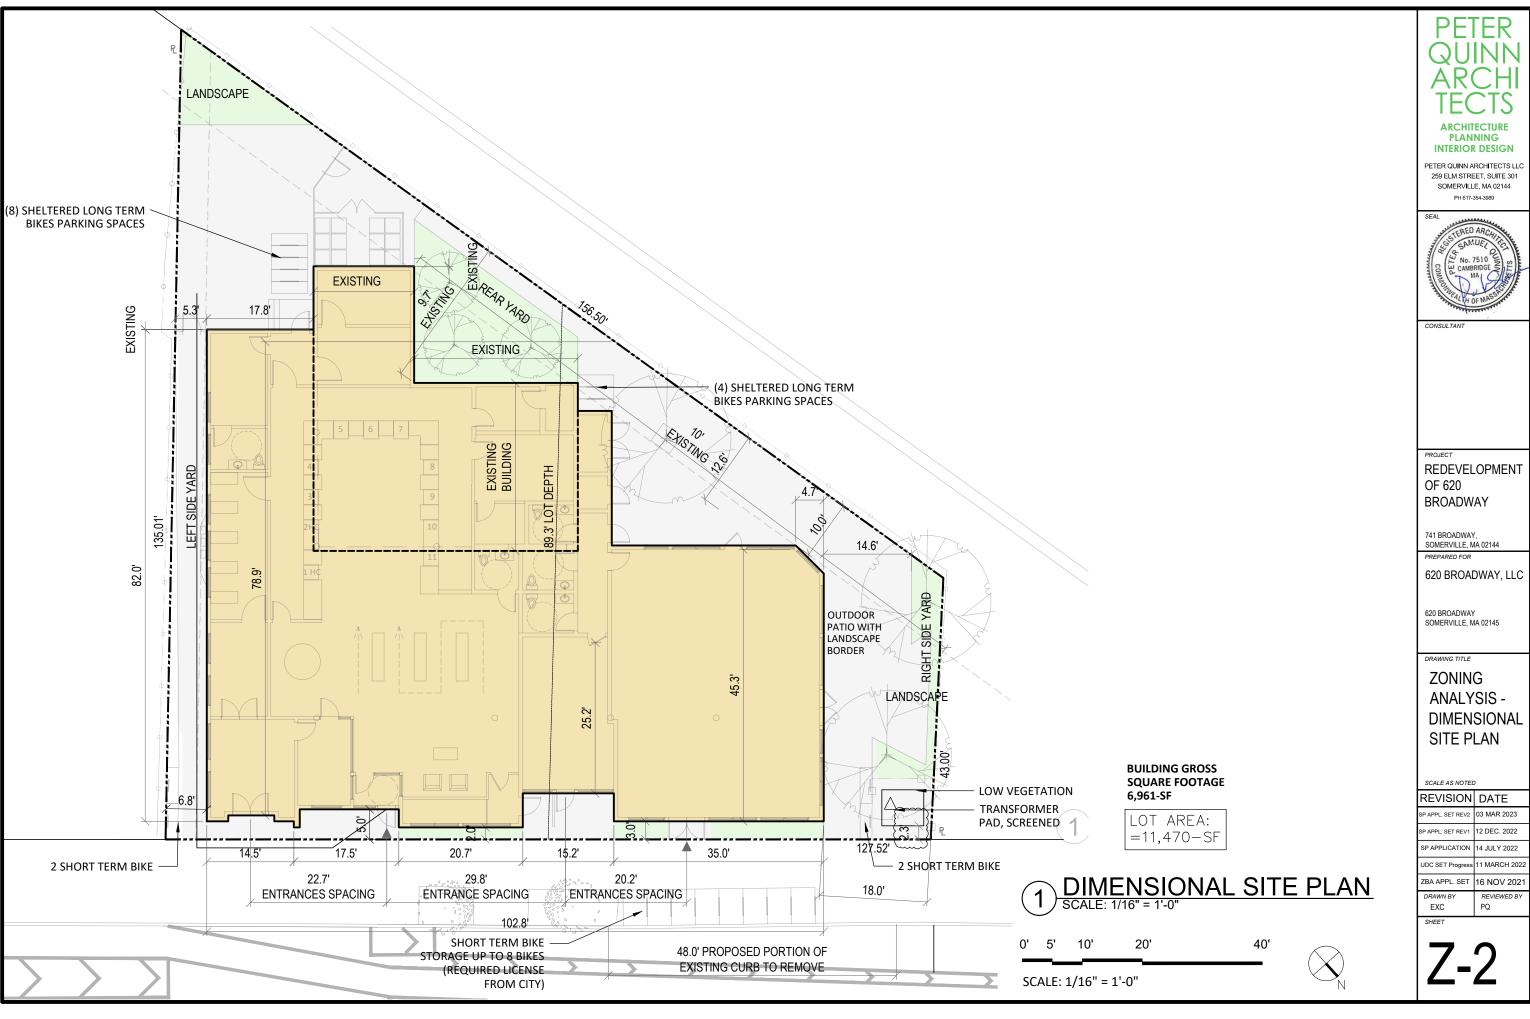



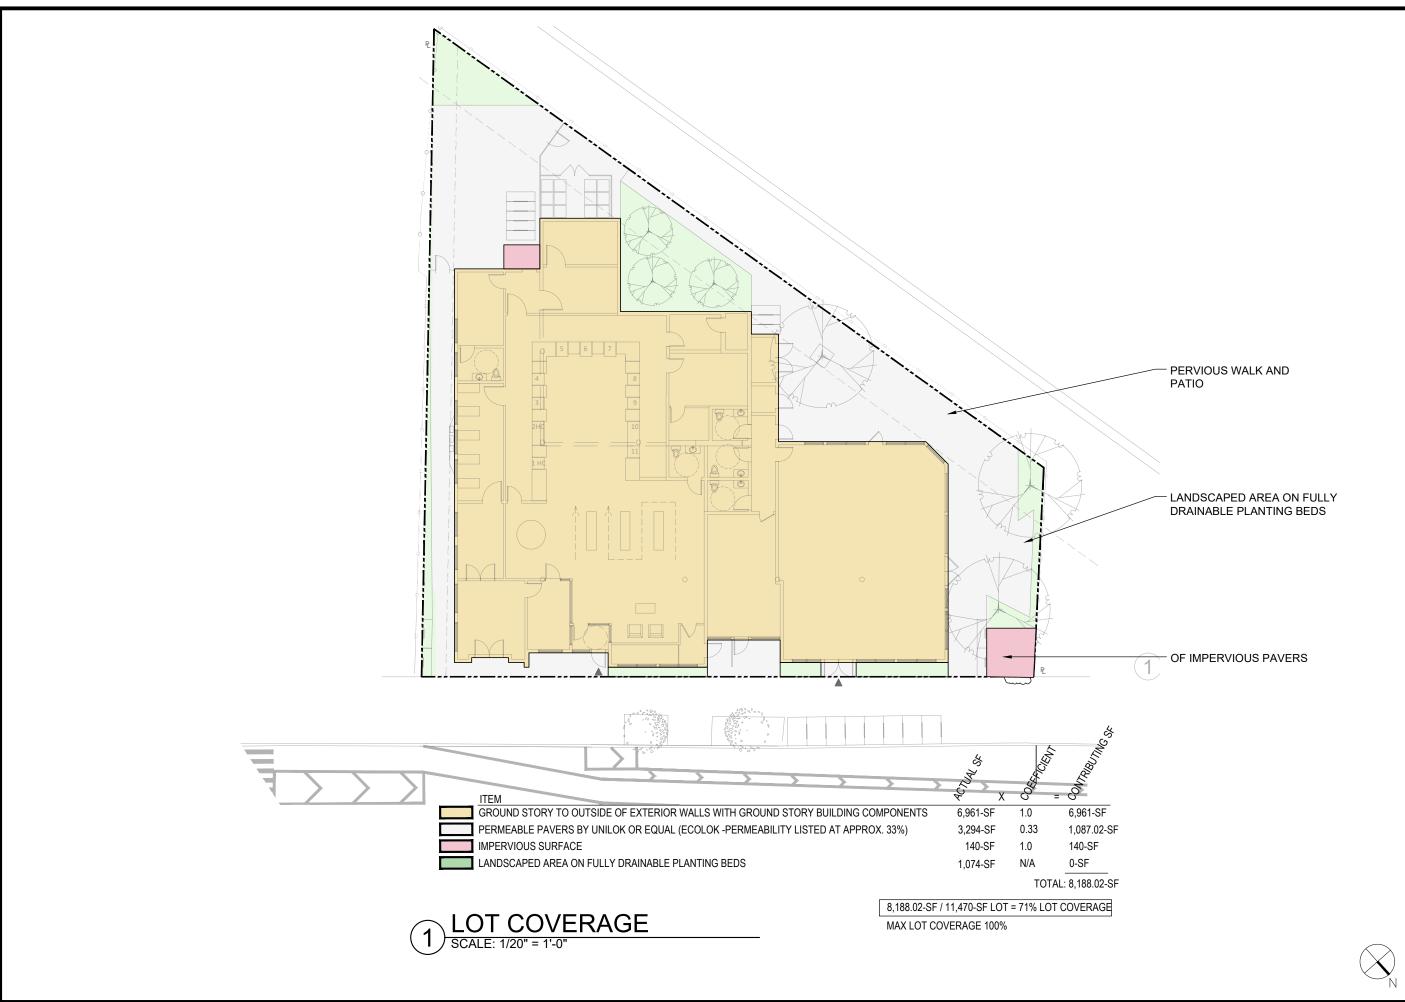

QUINN ARCHI TECTS

ARCHITECTURE PLANNING INTERIOR DESIGN

PETER QUINN ARCHITECTS LLC 259 ELM STREET, SUITE 301 SOMERVILLE, MA 02144 PH 617-354-3989



CONSULTANT

ROJECT

REDEVELOPMENT OF 620 BROADWAY

741 BROADWAY, SOMERVILLE, MA 02144 PREPARED FOR

620 BROADWAY, LLC

620 BROADWAY SOMERVILLE, MA 02145

DRAWING TITLE

ZONING ANALYSIS -LOT COVERAGE

SCALE AS NOTED

REVISION DATE

SP APPL. SET REV2 03 MAR 2023

SP APPLICATION 14 JULY 2022


UDC SET Progress 11 MARCH 202

ZBA APPL. SET 16 NOV 202

EXC PQ

EET PQ

**Z-3** 

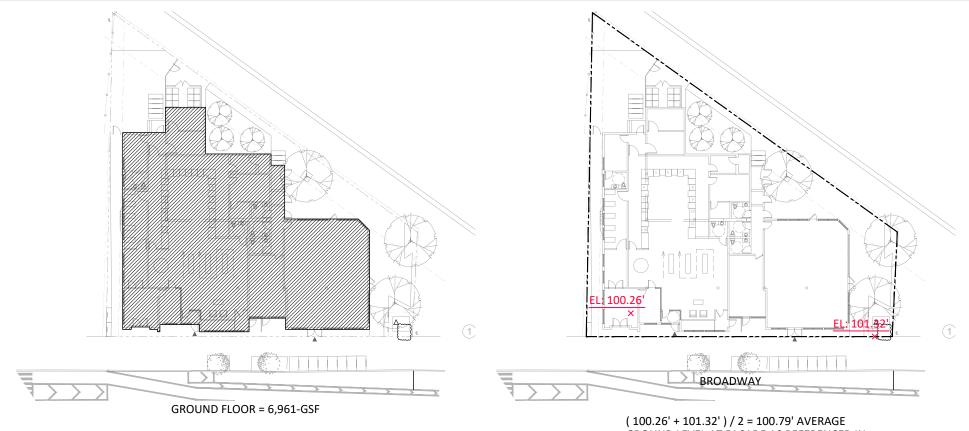

 $\bigcirc$ 

PROPOSED GROSS FLOOR AREA

SCALE: 1/40" = 1'-0"

( 100.26' + 101.32' ) / 2 = 100.79' AVERAGE GROUND LEVEL AT FACADE AS REFERENCED IN DEFINITION OF BUILDING HEIGHT.

# AVERAGE GROUND LEVEL SCALE: 1/40" = 1'-0"





## QUINN ARCHI TECTS

ARCHITECTURE PLANNING INTERIOR DESIGN

PETER QUINN ARCHITECTS LLC 259 ELM STREET, SUITE 301 SOMERVILLE, MA 02144 PH 617-354-3989



CONSULTAN

EDEVEL

REDEVELOPMENT OF 620 BROADWAY

741 BROADWAY, SOMERVILLE, MA 02144

620 BROADWAY, LLC

620 BROADWAY SOMERVILLE, MA 02145

DRAWING TITLE

ZONING ANALYSIS -GROSS FLOOR AREA, BUILDING HEIGHT

SCALE AS NOTED

M	REVISION	DATE		
	SP APPL. SET REV2	03 MAR 2		

SP APPL. SET REV1 12 DEC. 2022
SP APPLICATION 14 JULY 2022


UDC SET Progress 11 MARCH 20


ZBA APPL. SET 16 NOV 202

DRAWN BY REVIEWED BY


EXC

**Z-4** 

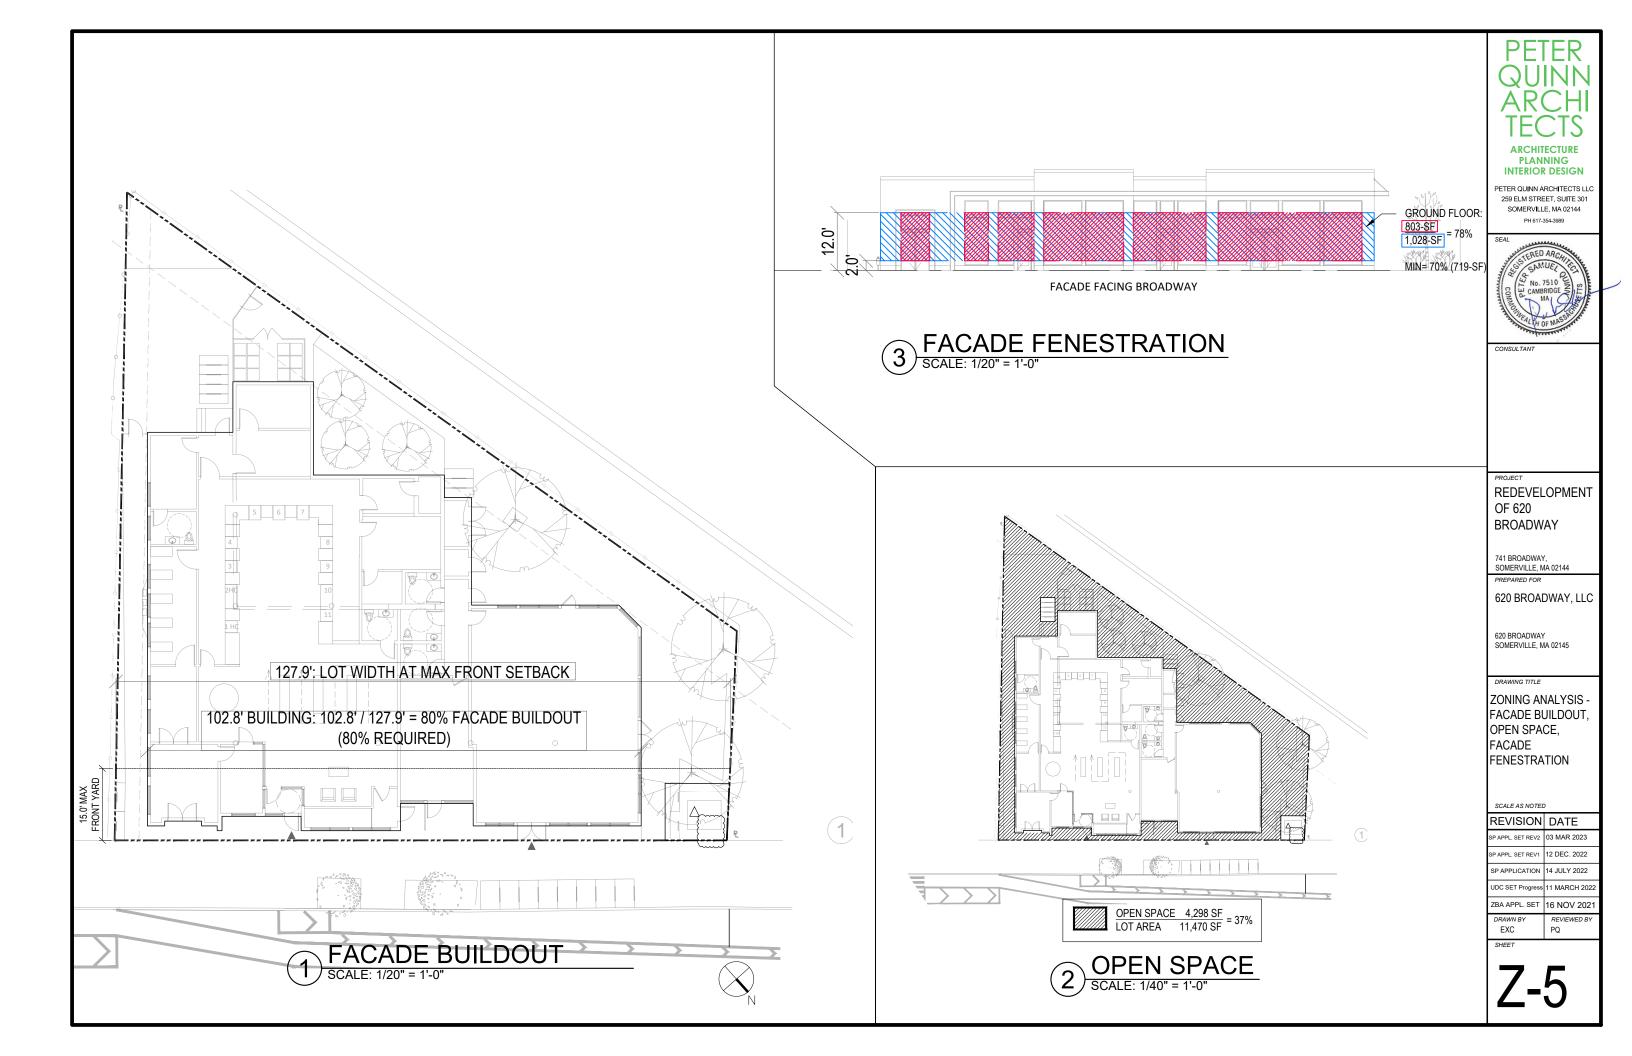

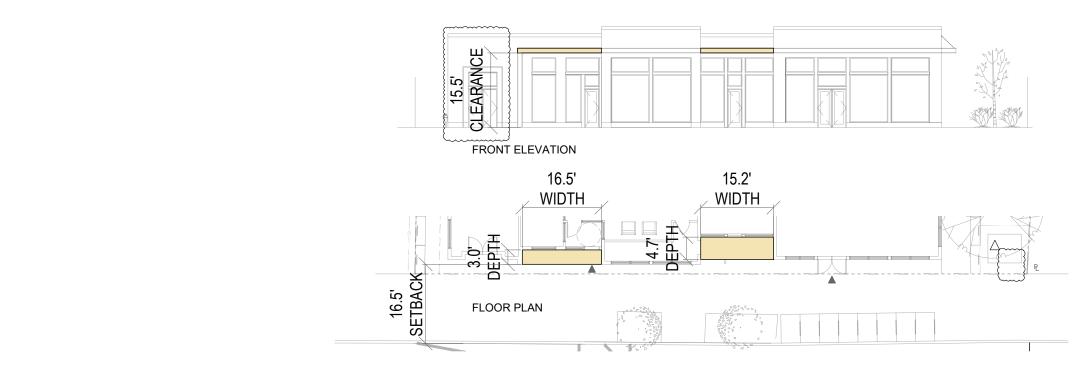

2 CANOPY DIMS
SCALE: 1/20" = 1'-0"

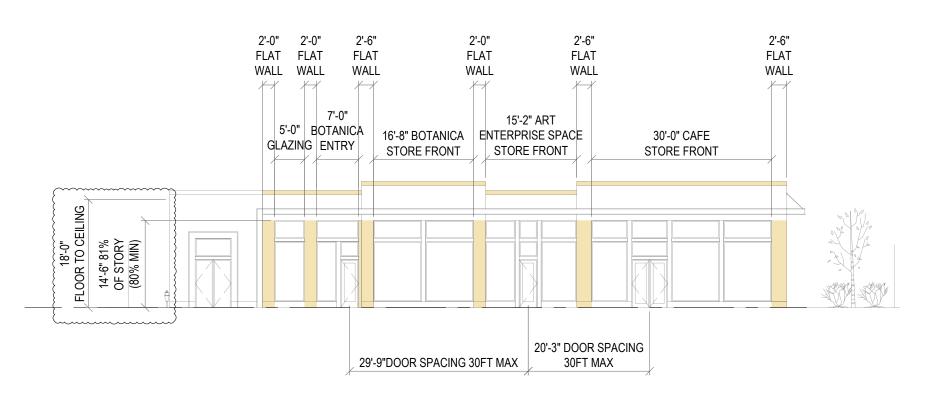

STOREFRONT FRAMING
SCALE: 1/16"=1'-0"

PETER QUINN ARCHI TECTS

ARCHITECTURE PLANNING INTERIOR DESIGN

PETER QUINN ARCHITECTS LL0 259 ELM STREET, SUITE 301 SOMERVILLE, MA 02144 PH 617-354-3989

SEAL SERED ARCHITECTURE OF THE SERENCE OF THE SEREN

CONSULTANT

PROJECT
REDEVELOPMENT
OF 620

741 BROADWAY, SOMERVILLE, MA 02144

BROADWAY

PREPARED FOR
620 BROADWAY, LLC

620 BROADWAY SOMERVILLE, MA 02145

DRAWING TITLE

ZONING ANALYSIS -STOREFRONT FRAMING

SCALE AS NOTED

## REVISION DATE

SP APPL. SET REV2 03 MAR 2023

SP APPL. SET REV1 12 DEC. 2022

SP APPLICATION 14 JULY 2022

UDC SET Progress 11 MARCH 202

ZBA APPL. SET 16 NOV 202

DRAWN BY

ON BY REVIEWED BY PQ

SHEET

**Z-6** 

















Site Furniture




Pervious Paving



City Approved Bike Rack



Greenscreen as Transformer Screen

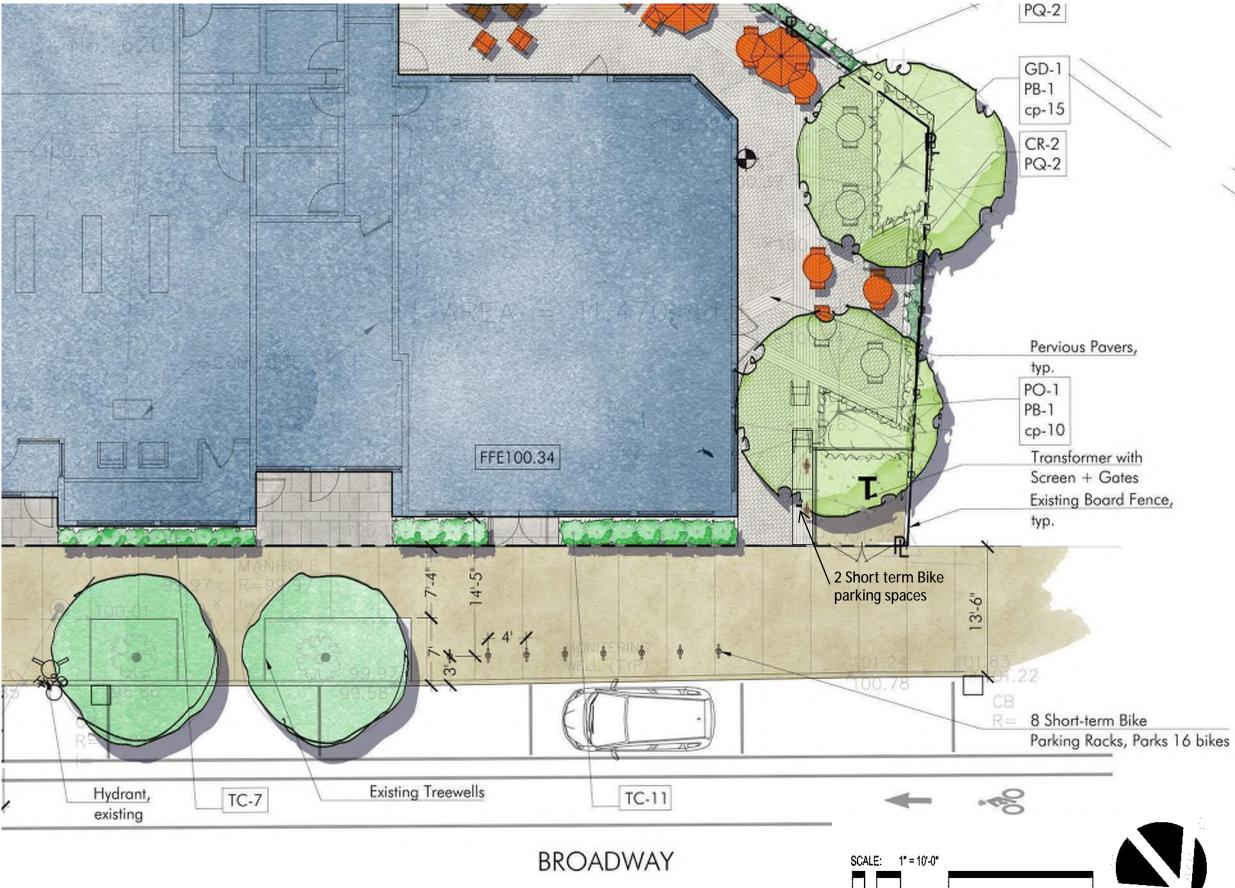













Bike Garage by Handi-Hut





Pervious Paving

Low-growing meadow






Somerville Green Score							
DIRECTIONS:	Area or						
	Number						
1. Enter the Lot Area in square feet to the right >>>	11,470						
Enter the area in square feet or the number of landscape elements		Sq Ft Credit	Multi- plier	Weighted Area	Score Value	% of Score	
Soils							
Landscaped area with a soil depth less than 24 inches (enter square feet)	0	actual sq ft	0.3	0	0.000	0%	
Landscaped area with a soil depth equal to or greater than 24 inches (enter square feet)	966	actual sq ft	0.6	579.6	0.051	16%	
Pervious Paving with 6 to 24 inches of subsurface soil or gravel (enter square feet)	2,772	actual sq ft	0.2	554.4	0.048	16%	
Pervious Paving with more than 24 inches of subsurface soil or gravel (enter square feet)	0	actual sq ft	0.5	0	0.000	0%	
Groundcovers			1	1	1		
Turf grass, mulch, and inorganic surfacing materials (enter square feet)	0	actual sq ft	0.1	0	0.000	0%	
Plants							
Vegetation less than two (2) feet tall at maturity (enter square feet)	465	actual sq ft	0.2	93	0.008	3%	
Vegetation at least two (2) feet tall at maturity (enter number of individual plants)	127	12	0.3	457.2	0.040	13%	
Trees							
Small Tree (enter number of trees)	0	50	0.6	0	0.000	0%	
Large Tree (enter number of trees)	7	450	0.6	1890	0.165	53%	
Preserved Tree (enter DBH)	0	65	0.8	0	0.000	0%	
Engineered Landscape							Possible Bonuses
Vegetated Wall (enter square feet)	0	actual sq ft	0.1	0	0.000	0%	Publicly Visible Land scape
Rain gardens, bioswales, and stormwater planters (enter square feet)	0	actual sq ft	1.0	0	0.000	0%	Native Species
Green Roof with up to 6" of growth medium (enter square feet)	0	actual sq ft	0.1	0	0.000	0%	High Value Species
Green Roof with 6"-10" of growth medium (enter square feet)	0	actual sq ft	0.4	0	0.000	0%	50% Irrigation from storm water
Green Roof of 10"-24" growth medium (enter square feet)	0	actual sq ft	0.6	0	0.000	0%	Food cultivation
Green Roof of over 24" growth medium	N/A	Calculate as trees	if soils,	groundcovers,	plants, and	N/A	De-paved lot area
			-		0.015		
				Green Score	0.312		
		Green Score	District	 Requirements			
		NR & UR	MR3	MR5, MR6,	FAB, CC,		
			& MR4	& HR	CB, CI		
	Required Score:	0.35	0.25	0.20	0.20		
	Target Score:	0.40	0.3	0.25	-		
	Actual Green	0.312	0.312	0.312	0.312		
	Score:						





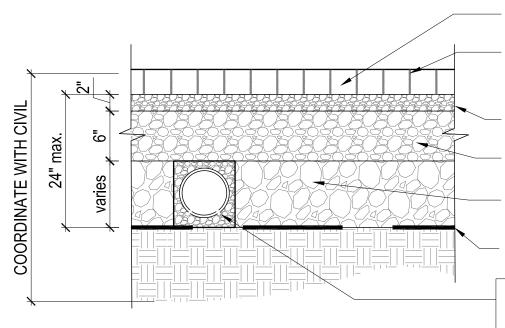

Permeable pavers by Unilock, see specifications permeable joint opening aggregate; filled with  $\frac{1}{8}$ " open graded crushed, angular stone; (ASTM #8)

2" Leveling Course open graded stone (ASTM #8)

Base Course  $\frac{3}{4}$ "-I" open graded stone no fines (ASTM #57)

Reservoir Course I  $\frac{1}{2}$ "-3" open graded stone no fines (ASTM #2)

Geotextile soil separation, see specification


pvc underdrain pipe; location as shown on Civil drawings, install if infiltration is less than 0.5 in./hr. typ. if shown in Civil drawing


### Notes:

. Edge restraints vary see plan.

- 2. All aggregate material shall be crushed, angular stone and free of fines.
- 3. Compact subsoil with a California bearing ratio (cbr) of less than 5% as directed by a professional engineer.
- 4. Surface slope shall be a minimum of 1% and a maximum of 5%.
- 5. Install pvc underdrain pipe where infiltration rate of subsoil is less than 0.5 in./hr. size as directed by a professional engineer.
- 6. Never build permeable pavements on organic clay soils of high plasticity and/or peat, mulch, soils with high organic content.
- 7. Maintain a minimum distance of 2' between bottom of permeable base and water table.
- 8. The minimum aggregate thicknesses are after compaction.

PERMEABLE UNIT PAVER DETAIL

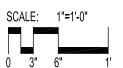

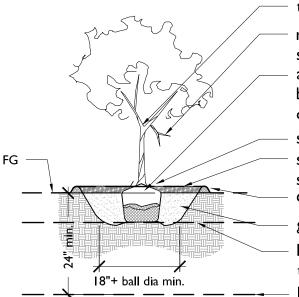

tree or shrub

remove damaged branches and suckers all twine, ropes, pots and wire shall be totally removed, remove top 2/3

of burlap set rootflare I" above finish grade settled pine mulch 3" min., no mulch


shall cover root flare create saucer with topsoil 2" min.

gently compacted plant mix

First 6" lift of planting mix blended into the top 6" of existing subsoil

Loosen subsoils to a minimum of -24" below f.g.

TYPICAL PLANT (TREE OR SHRUB) DETAIL

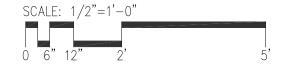






APRIL 11, 22



1 AERIAL VIEW 1

3D-1

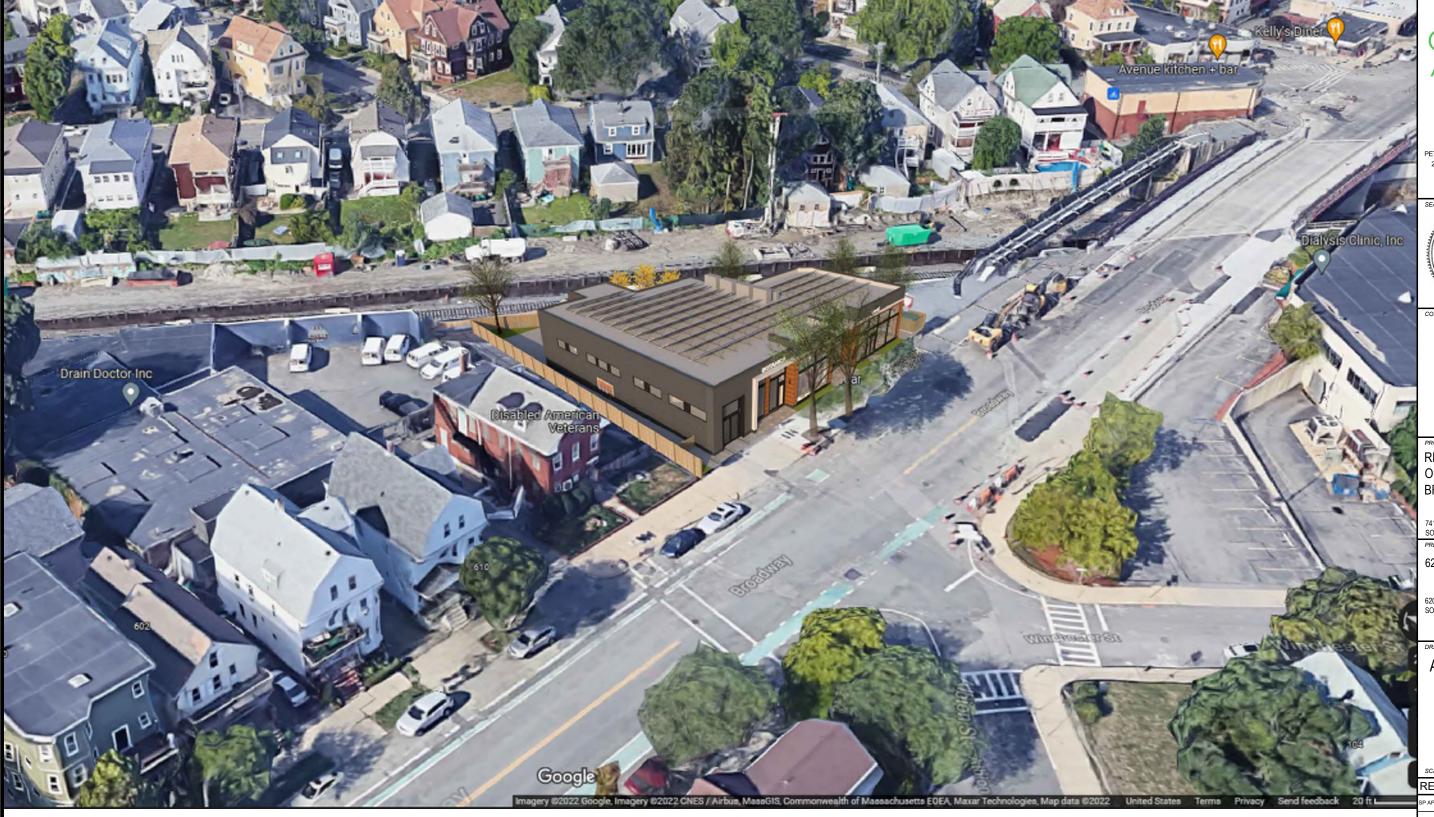

1 AERIAL VIEW 2

## QUINN ARCHI TECTS

ARCHITECTURE PLANNING INTERIOR DESIGN

PETER QUINN ARCHITECTS LLC 259 ELM STREET, SUITE 301 SOMERVILLE, MA 02144 PH 617-354-3989



CONSULTANT

OJECT

## REDEVELOPMENT OF 620 BROADWAY

741 BROADWAY, SOMERVILLE, MA 02144 PREPARED FOR

620 BROADWAY, LLC

620 BROADWAY SOMERVILLE, MA 02145

DRAWING TITLE

**AERIAL VIEW 2** 

SCALE AS NOTED

## REVISION DATE


JDC SET Progress 11 MARCH 202

ZBA APPL. SET 16 NOV 202

EXC F

SHEET

3D-2

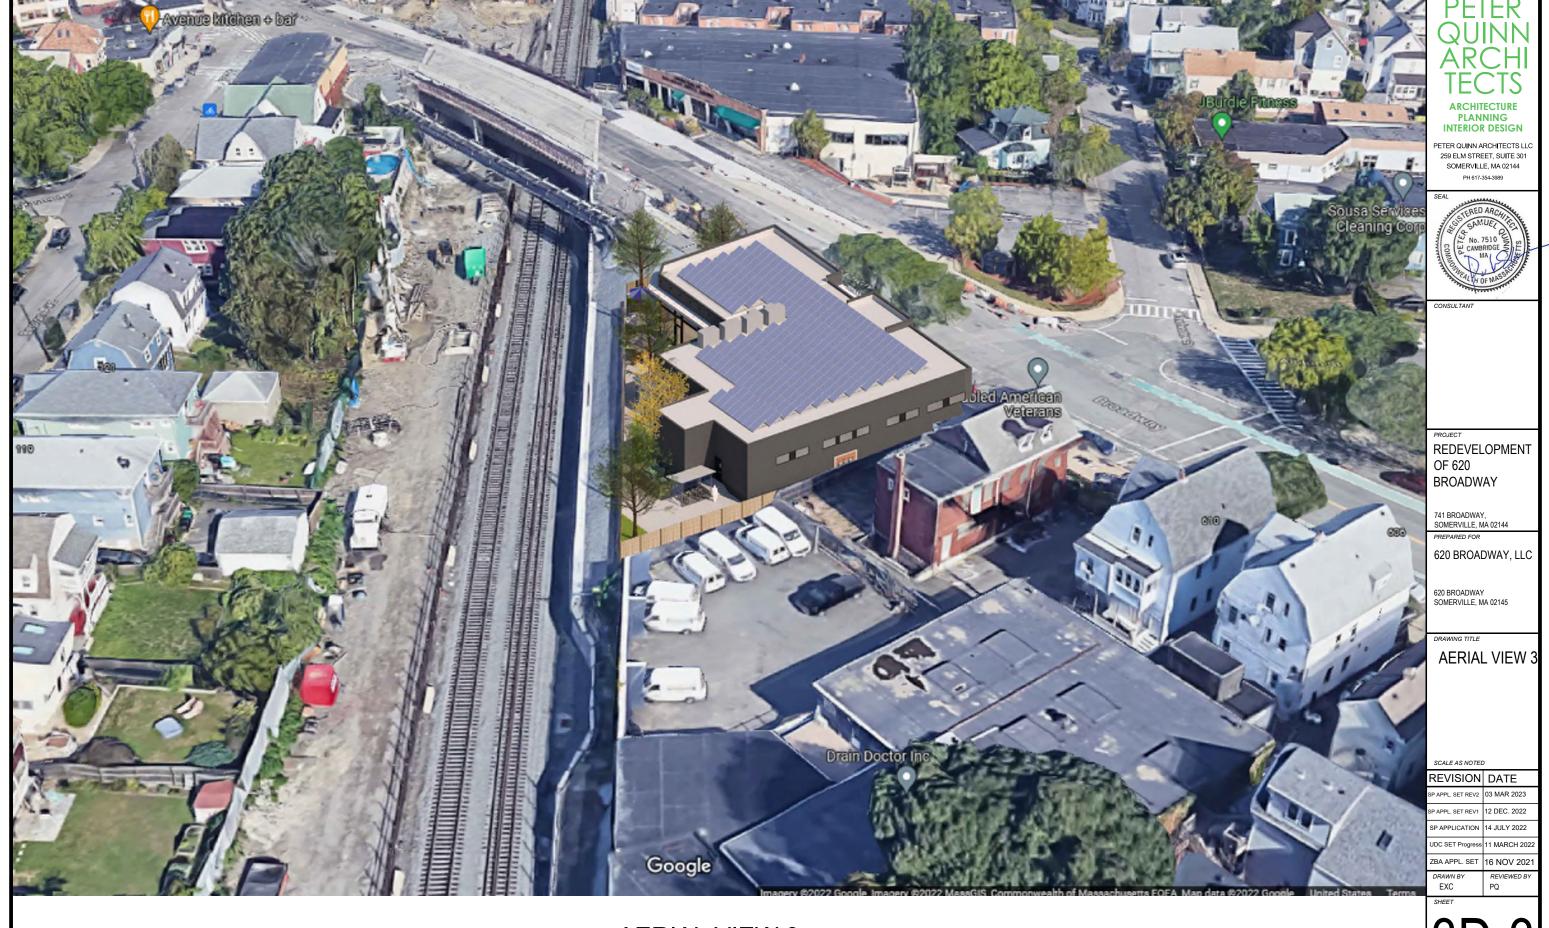

1 AERIAL VIEW 3

3D-3



ARCHITECTURE PLANNING INTERIOR DESIGN

PETER QUINN ARCHITECTS LLC 259 ELM STREET, SUITE 301 SOMERVILLE, MA 02144



REDEVELOPMENT OF 620 BROADWAY

741 BROADWAY, SOMERVILLE, MA 02144

620 BROADWAY, LLC

620 BROADWAY SOMERVILLE, MA 02145

**AERIAL VIEW 4** 

#### REVISION DATE

APPL. SET REV1 12 DEC. 2022 14 JULY 2022

ZBA APPL. SET 16 NOV 202



RENDERING DOES NOT PORTRAY PROPOSED GM2 ROAD DESIGN. SEE FLOOR PLANS OR TRAFFIC IMPACT STUDY FOR PROPOSED DESIGN.

1 STREET VIEW/LEFT ELEVATION

PLANNING INTERIOR DESIGN

PETER QUINN ARCHITECTS LLC 259 ELM STREET, SUITE 301 SOMERVILLE, MA 02144

REDEVELOPMENT OF 620 BROADWAY

741 BROADWAY, SOMERVILLE, MA 02144

620 BROADWAY, LLC

620 BROADWAY SOMERVILLE, MA 02145

STREET VIEW/ LEFT **ELEVATION** 

SCALE AS NOTED

#### REVISION DATE



RENDERING DOES NOT PORTRAY PROPOSED GM2 ROAD DESIGN. SEE FLOOR PLANS OR TRAFFIC IMPACT STUDY FOR PROPOSED DESIGN.

1 STREET VIEW/ RIGHT ELEVATION

PLANNING INTERIOR DESIGN

PETER QUINN ARCHITECTS LLC 259 ELM STREET, SUITE 301 SOMERVILLE, MA 02144



REDEVELOPMENT OF 620 BROADWAY


741 BROADWAY, SOMERVILLE, MA 02144

620 BROADWAY, LLC

620 BROADWAY SOMERVILLE, MA 02145

STREET VIEW/ RIGHT **ELEVATION** 

### REVISION DATE

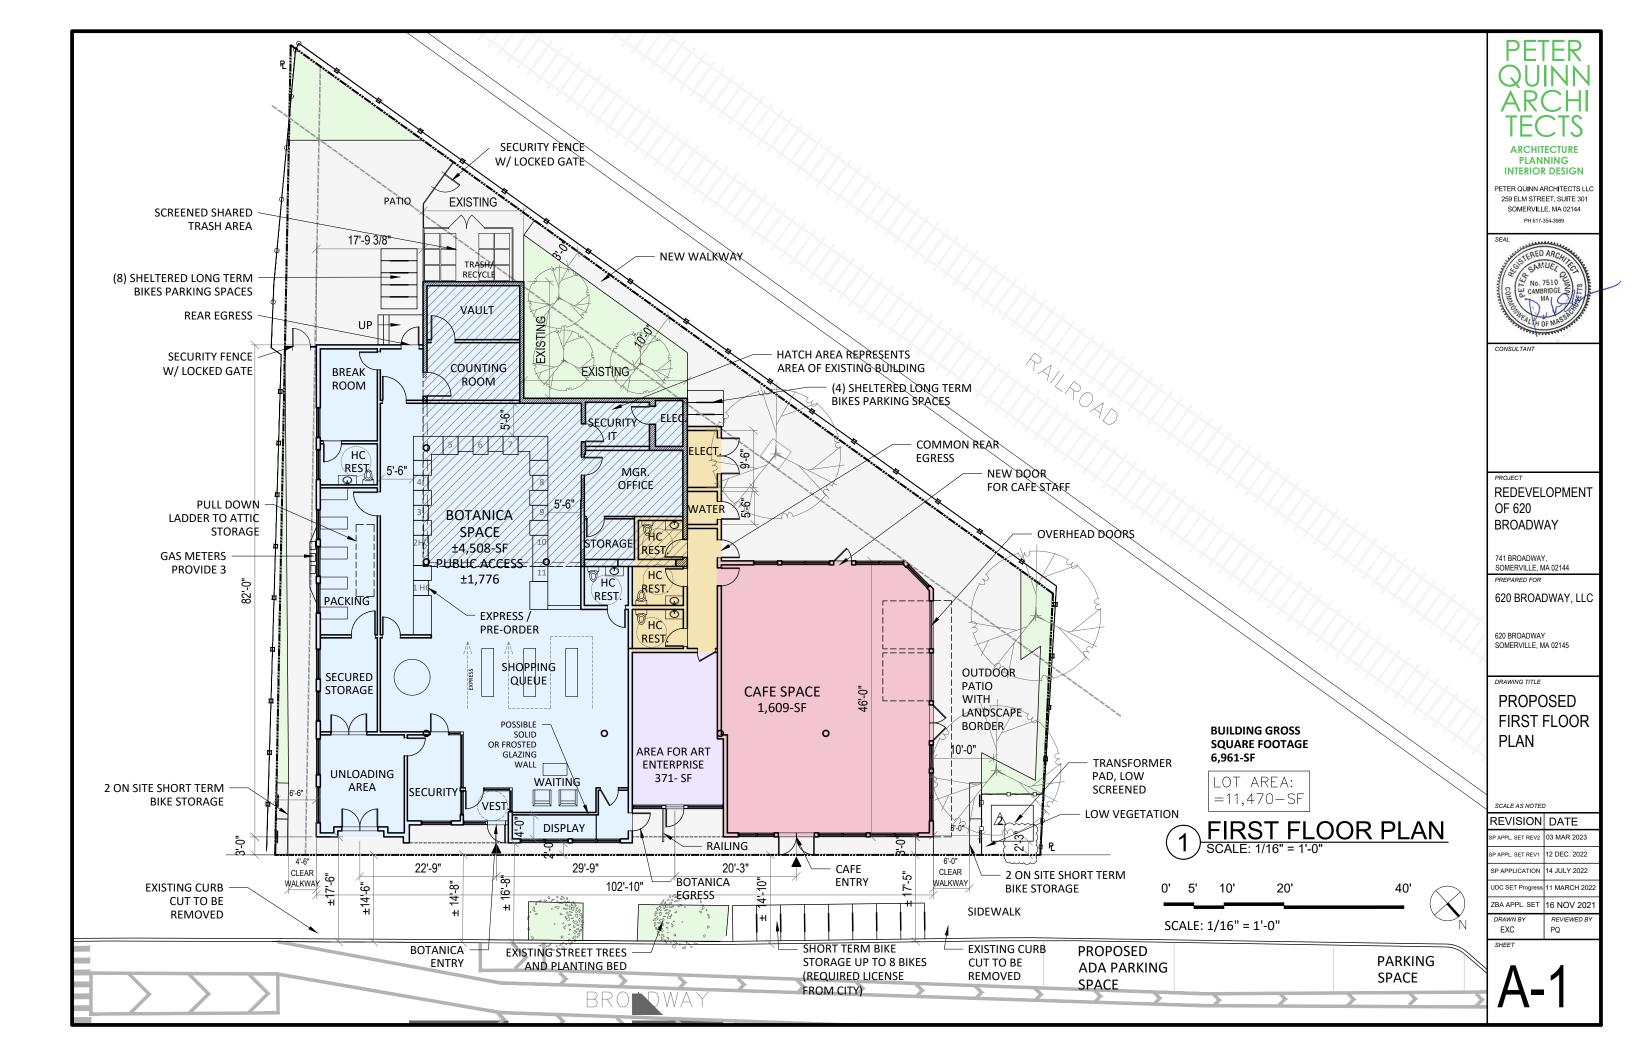







**ALUMINUM TONGUE & GROOVE** LONGBOARD ARCHITECTURAL **PRODUCTS** 6" V GROOVE DARK GRAY



**ALUMINUM TONGUE & GROOVE** LONGBOARD ARCHITECTURAL **PRODUCTS** 4" V GROOVE DARK FIR



TEMPERED GLAZING **ALUMINUM** STOREFRONT ANODIZED BLACK



**ALUMINUM CANOPY** POWDER COATING WHITE



DARK SKY OUTDOOR WALL SCONCE AT **ENTRIES** 8' ABOVE GRADE **BLACK** 

PLANNING INTERIOR DESIGN

PETER QUINN ARCHITECTS LLC 259 ELM STREET, SUITE 301 SOMERVILLE, MA 02144 PH 617-354-3989



REDEVELOPMENT OF 620

**BROADWAY** 

741 BROADWAY, SOMERVILLE, MA 02144

620 BROADWAY, LLC

620 BROADWAY SOMERVILLE, MA 02145

DRAWING TITLE

PROPOSED MATERIAL SHEET

SCALE AS NOTEL	)
REVISION	DATE
SP APPL. SET REV2	03 MAR 2023
SP APPL. SET REV1	12 DEC. 2022
SP APPLICATION	14 JULY 2022
UDC SET Progress	11 MARCH 202
ZBA APPL. SET	16 NOV 202
DRAWN BY YC	REVIEWED BY PQ



RIGHT ELEVATION
SCALE: 1/8"=1'-0"

ARCHITECTURE PLANNING INTERIOR DESIGN

PETER QUINN ARCHITECTS LLC 259 ELM STREET, SUITE 301 SOMERVILLE, MA 02144 PH 617-354-3989



REDEVELOPMENT OF 620

741 BROADWAY, SOMERVILLE, MA 02144

620 BROADWAY, LLC

620 BROADWAY SOMERVILLE, MA 02145

PROPOSED RIGHT **ELEVATION** 

SCALE AS NOTED

REVISION	DAT


P APPL. SET REV2 03 MAR 2023 SP APPL. SET REV1 12 DEC. 2022


SP APPLICATION 14 JULY 2022

ZBA APPL. SET 16 NOV 202 REVIEWED BY

EXC



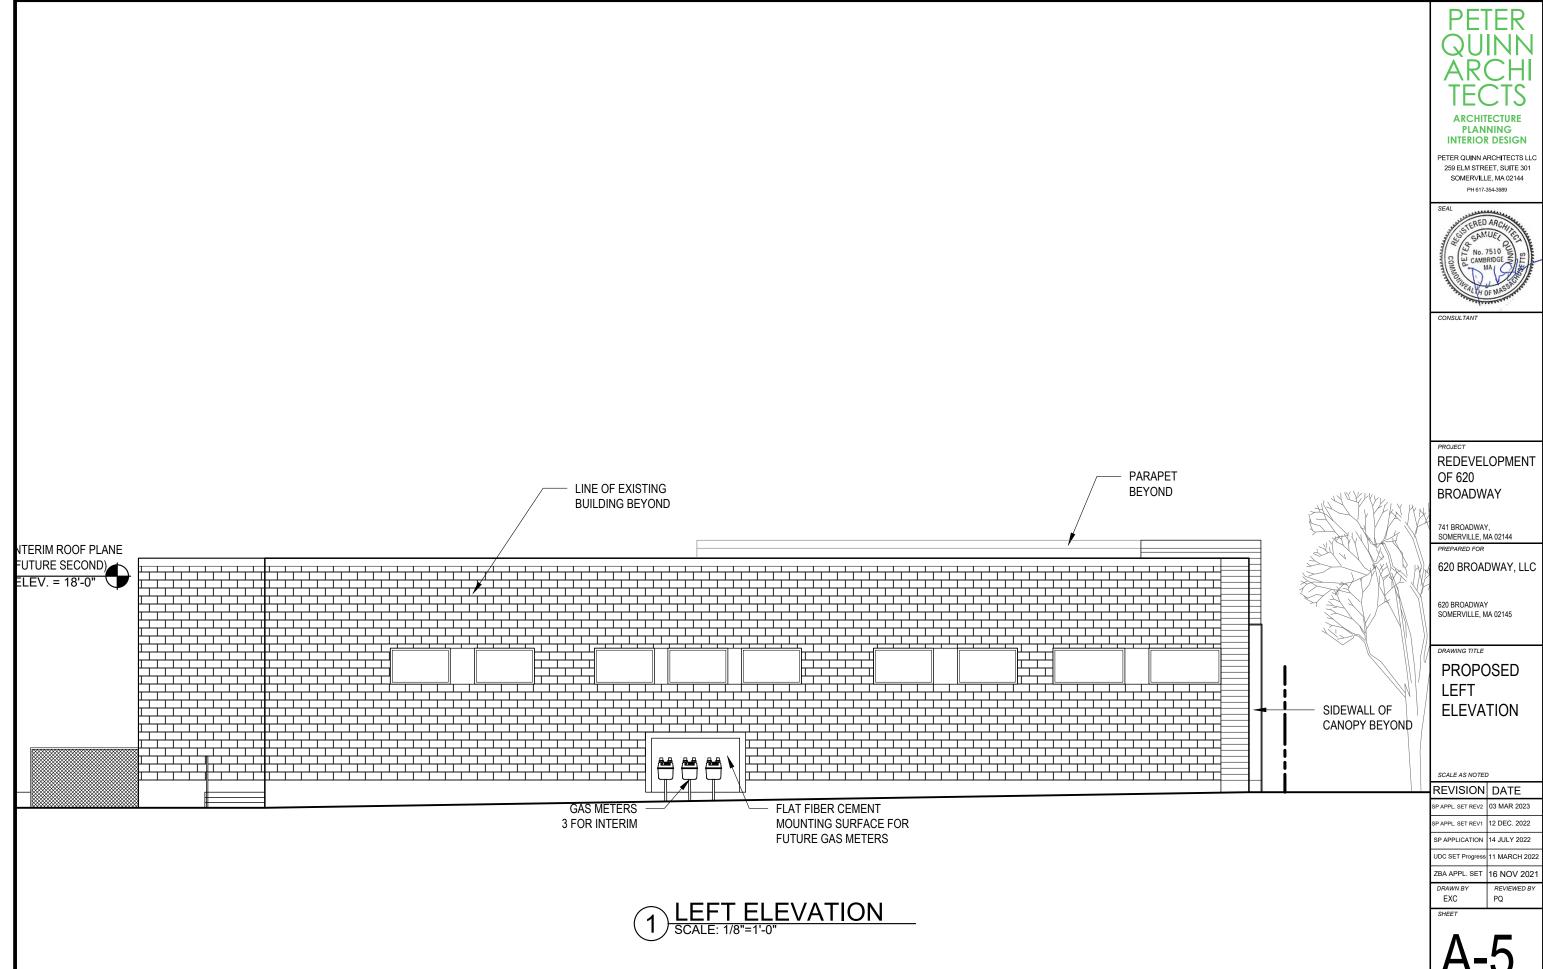


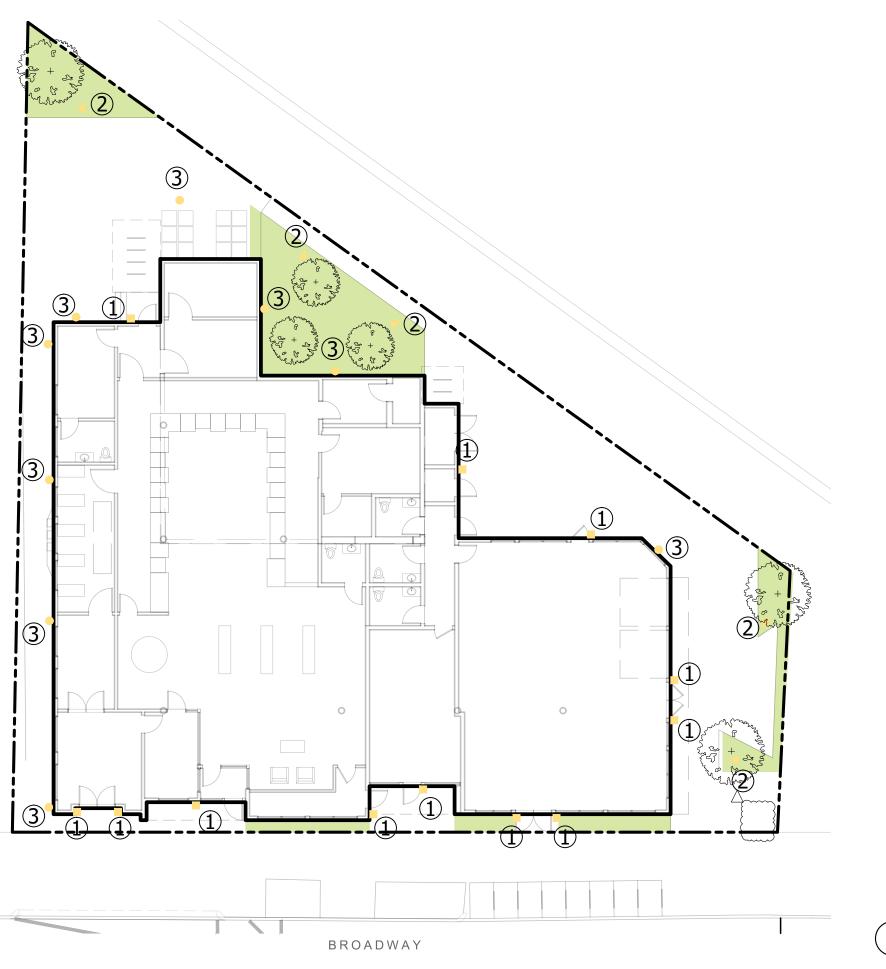




- DARK SKY OUTDOOR WALL SCONCE AT ENTRIES:
  - 8' ABOVE FINISHED FLOOR
  - DARK SKY FRIENDLY
  - BLACK



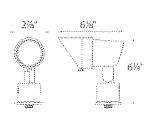

- SPOT LIGHT ON LANDSCAPE (ACCENT 5012):
  - ON GRADE, ADJUSTABLE & LOCKABLE BEAM ANGLE
     INTEGRAL DIMMER

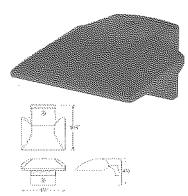

- SPOT LIGHT AT PATIO & WALKWAY (WP - LED2):
  - 9' ABOVE FINISHED FLOOR
  - MULTI--FUNCTION DIMMING

EXTERIOR LIGHTING PLAN
SCALE: 1/16" = 1'-0"

PLANNING INTERIOR DESIGN

PETER QUINN ARCHITECTS LLC 259 ELM STREET, SUITE 301 SOMERVILLE, MA 02144 PH 617-354-3989



REDEVELOPMENT OF 620 BROADWAY

741 BROADWAY, SOMERVILLE, MA 02144

620 BROADWAY, LLC

620 BROADWAY SOMERVILLE, MA 02145

DRAWING TITLE


EXTERIOR LIGHTING PLAN


SCALE AS NOTED

### REVISION DATE APPL SET REV2 03 MAR 2023

P APPL. SET REV1 12 DEC. 2022 SP APPLICATION 14 JULY 2022

ZBA APPL. SET 16 NOV 202

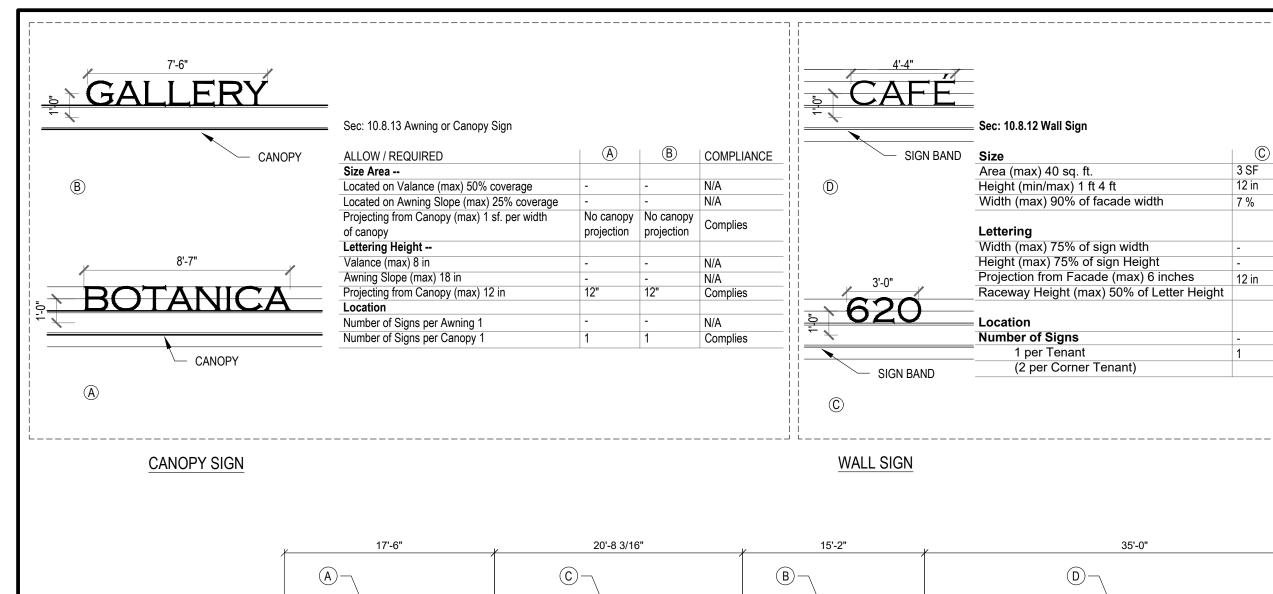

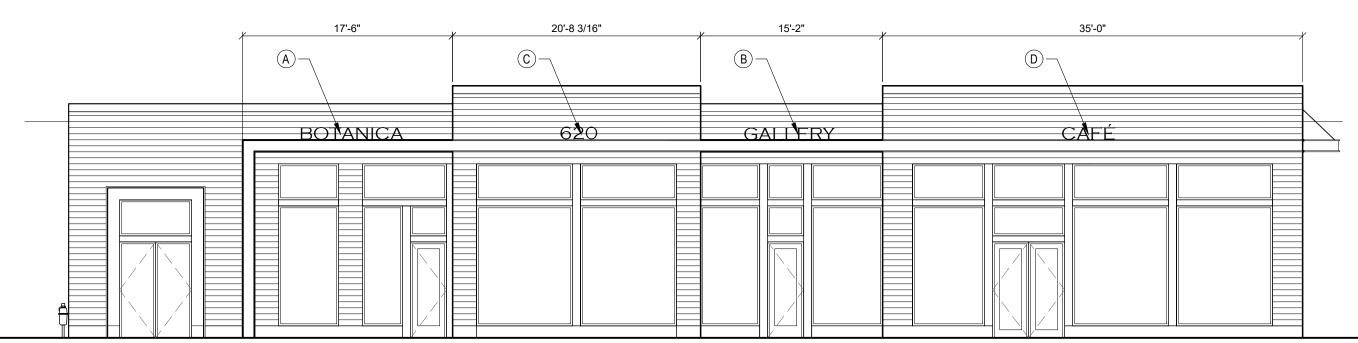

NOTES:

1-ALL SIGNS TO COMPLY WITH THE CITY OF SOMERVILLE'S DEVELOPMENT STANDARDS (COMMERCIAL SIGNS) SEC. 10.8 OF ZONING ORDINANCE.

2- ALL SIGNS AND DIMENSIONS ARE PRELIMINARY AND ARE SUBJECT TO CHANGE BASED ON FURTHER DESIGN BY TENANTS.

PLANNING INTERIOR DESIGN

(D)

4.3 SF

12 in

8 %

12 in

COMPLIANCE

Complies

Complies

N/A

N/A

N/A

Complies

Complies

PETER QUINN ARCHITECTS LLC 259 ELM STREET, SUITE 301 SOMERVILLE, MA 02144 PH 617-354-3989



**REDEVELOPMENT** OF 620 BROADWAY

> 741 BROADWAY. SOMERVILLE, MA 02144

620 BROADWAY, LLC

620 BROADWAY SOMERVILLE, MA 02145

DRAWING TITLE

**SIGNAGE** 

SCALE AS NOTED

REVISION DATE APPL. SET REV2 03 MAR 2023

P APPL. SET REV1 12 DEC. 2022

SP APPLICATION 14 JULY 2022

ZBA APPL. SET 16 NOV 202

REVIEWED B

PQ

